SECTION 4.55 - MODIFICATION

ALTERATIONS & ADDITIONS - FIRST FLOOR ADDITION 19 EARLWOOD AVENUE

FOR

MR STAMATIS DRAKOS

DRAWING LIST

	Sheet No.		She	et Nar	ne	
	01	EXISTING SITE & ROOF PLAN				
	02	PROPOSED DEMOLITION PLAN				
	03	PROPOSED SITE PLAN				
	07	PROPOSED GROUND FLOOR PL	AN			
	08	PROPOSED FIRST FLOOR PLAN				
	09	PROPOSED ROOF PLAN				
	10	PROPOSED NORTHERN & SOUTH	IERNI ELEVAT			
	10	PROPOSED EASTERN & WESTERN				
	12	PROPOSED CROSS & LONGITUD		JIN2		
	13	PROPOSED LONGITUDINAL SECT				
	14	PROPOSED WINDOW SCHEDULE				
	15	PROPOSED DOOR SCHEDULE				
	16	PROPOSED BASIX COMMITMENT	TS			
	17	B.C.A NCC SPECIFICATIONS				
- AME	IDMENT NOTES: ISS ND ROOF RIDGE ERAL REVIEW OF V	ue d - 12/09/2023 Vindows				MR STAMATIS DRAK
D	SECTION 4.55 - MODIFICATIO		12-09-2023	D.P	E.J.S	
C B	CONSTRUCTION CERTIFICA ADDITIONAL INFORMATION		28-07-21 25-06-21	M.K M.K	E.J.S E.J.S	ADDRESS
A	DEVELOPMENT APPLICATIO		19-05-2021	M.K	E.J.S	19 EARLWOOD AVEN
ISSUE		AMENDMENTS	DATE	DRN	CHK	



IDMENT NOTES: ISSUE D - 12/09/2023 :ND ROOF RIDGE IERAL REVIEW OF WINDOWS				MR STAMATIS DRAKOS	ALTERATIONS & ADDITIONS - FIRST FLOOR ADDITION	DRAWING THE				
SECTION 4.55 - MODIFICATION TO DA	12-09-2023	D.P	E.J.S			SHEET NO:	00		ISSUE:	D
CONSTRUCTION CERTIFICATE	28-07-21	M.K	E.J.S	ADDRESS	PROJECT STATUS					
ADDITIONAL INFORMATION FOR COUNCIL LETTER	25-06-21	M.K	E.J.S	19 EARLWOOD AVENUE	SECTION 4.55 - MODIFICATION	SCALE:	@A3		JOB NO:	888 1539
DEVELOPMENT APPLICATION	19-05-2021	M.K	E.J.S	19 EARLWOOD AVENUE	SECTION 4.33 - MODIFICATION					
AMENDMENTS	DATE	DRN	CHK			DESIGN: E	IS	DRAWN: D.P	CHECKED BY:	E.J.S

Y:\AAA-DRAWING FILES\888-1539\02 - DRAWING FILES\REVIT\03 - DWELLING DRAWINGS\888-1539 - 19 Earlwood Ave, Earlwood.rvt



o40<u>7.com.au</u>








COPYRIGHT of desi DESIGN STUDIO 407. Authority is required for any eproduction

Contractor(s) to verify all dimensions on site before commencing work. Figured dimensions given are to be taken in preference to scaling.



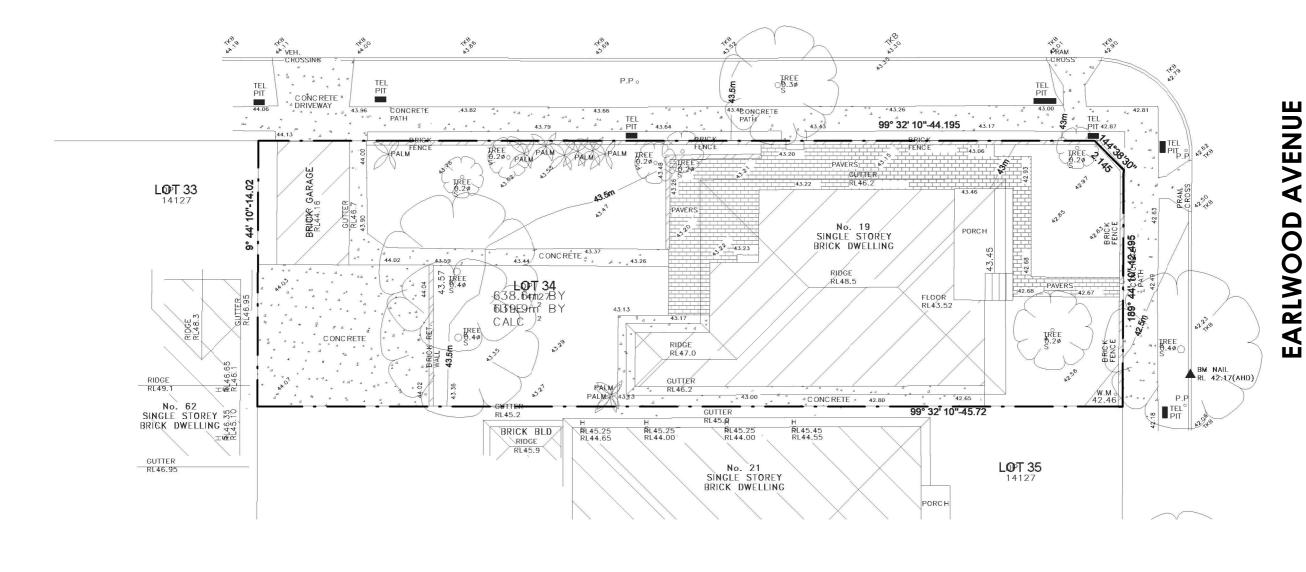



- AME	IDMENT NOTES: ISSUE D - 12/09/2023 END ROOF RIDGE IERAL REVIEW OF WINDOWS				CLIENT MR STAMATIS DRAKOS	ALTERATIONS & ADDITIONS - FIRST FLOOR ADDITION	DRAWING TI	^{π.ε} NG SITE & ROOF PLA	N	
D	SECTION 4.55 - MODIFICATION TO DA	12-09-2023	D.P	E.J.S			SHEET NO:	01	ISSUE:	D
С	CONSTRUCTION CERTIFICATE	28-07-21	M.K	E.J.S	ADDRESS	PROJECT STATUS				
В	ADDITIONAL INFORMATION FOR COUNCIL LETTER	25-06-21	M.K	E.J.S	19 EARLWOOD AVENUE	SECTION 4.55 - MODIFICATION	SCALE:	1 : 200@A3	JOB NO:	888 1539
A	DEVELOPMENT APPLICATION	19-05-2021	M.K	E.J.S	19 EARLWOOD AVENUE	SECTION 4.55 - MODIFICATION				
ISSUE	AMENDMENTS	DATE	DRN	CHK			DESIGN: E	JS DRAWN: D.P	CHECKED BY	E.J.S





E admin@designstudio407.com.au W www.designstudio407.com.au




A Member Australian Instit of Architects

COPYRIGHT of designs shown heron is retained by DESIGN STUDIO 407. Authority is required for any reproduction. Contractor(s) to verify all dimensions on site before

commencing work. Figured dimensions given are to be taken in preference to scaling.



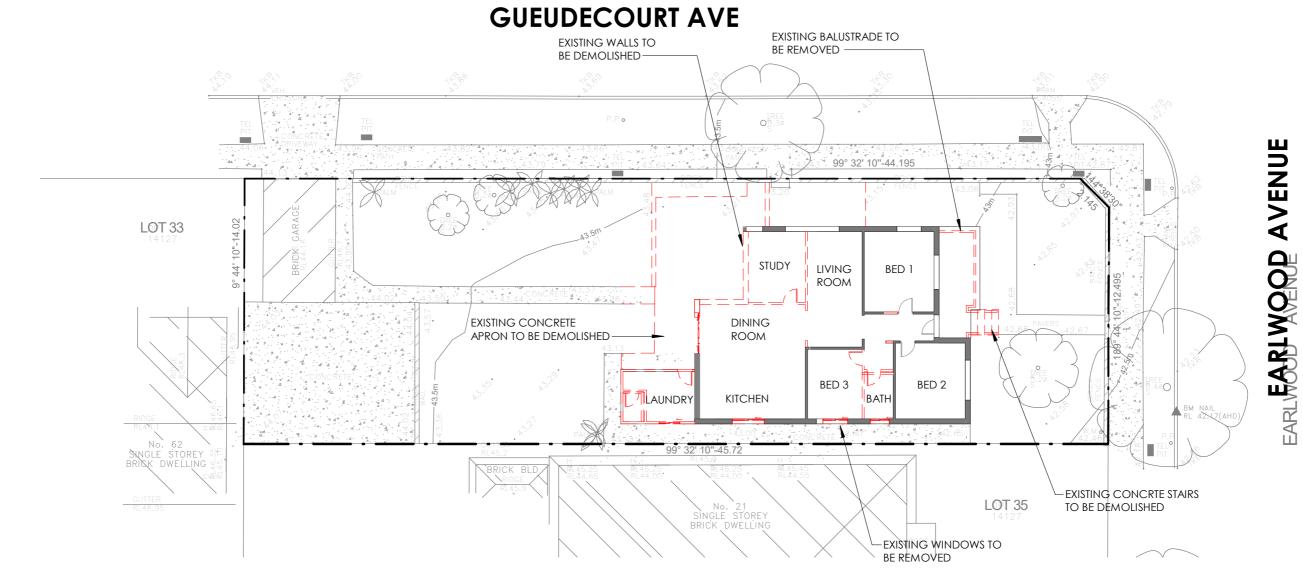



- AME	IDMENT NOTES: ISSUE D - 12/09/2023 END ROOF RIDGE IERAL REVIEW OF WINDOWS				MR STAMATIS DRAKOS	PROJECT ALTERATIONS & ADDITIONS - FIRST FLOOR ADDITION	DRAWING T	DSED DEMOLITION PL/	AN	
D	SECTION 4.55 - MODIFICATION TO DA	12-09-2023	D.P	E.J.S			SHEET NO:	02	ISSUE:	D
С	CONSTRUCTION CERTIFICATE	28-07-21	M.K	E.J.S	ADDRESS	PROJECT STATUS				
В	ADDITIONAL INFORMATION FOR COUNCIL LETTER	25-06-21	M.K	E.J.S	19 EARLWOOD AVENUE		SCALE:	1 : 200@A3	JOB NO:	888 1539
A	DEVELOPMENT APPLICATION	19-05-2021	M.K	E.J.S	19 EARLWOOD AVENUE	SECTION 4.55 - MODIFICATION				
ISSUE	AMENDMENTS	DATE	DRN	CHK			design: E	JS DRAWN: D.P	CHECKED BY:	E.J.S
			1							










COPYRIGHT of designs shown heron is retained by

COPYRIGHT of designs shown heron is retained by DESIGN STUDIO 407. Authority is required for any reproduction. Contractor(s) to verify all dimensions on site before commencing work. Figured dimensions given are to be taken in preference to scaling.

GENERAL NOTES

- DOUBLE BRICK CONSTRUCTION WITH CEMENT RENDER & PAINT FINISH TO GROUND FLOOR
 BRICK VENEER CONSTRUCTION WITH CEMENT RENDER & PAINT FINISH TO FIRST FLOOR
 RC SLABS, FOOTINGS, BEAMS AND STAIRS TO ENGINEER'S DETAILS
- COLORBOND ALUMINIUM GUTTERS, FASCIAS AND DOWNPIPES
- POWDERCOATED ALUMINIUM WINDOW AND DOOR ASSEMBLIES REFER TO SCHEDULES
- SELECTED TIMBER ENTRY DOOR WITH PAINT FINISH
- TIMBER FRAMED ROOF STRUCTURE AS PER LIGHT TIMBER FRAME CODE WITH SELECTED TILE FINISH
- SELECTED 1000mm HIGH BALUSTRADING
- REFER TO BASIX FOR WATER, ENERGY AND THERMAL COMFORT COMMITMENTS
- REFER TO HYDRAULIC ENGINEERS DRAWINGS FOR STORMWATER MANAGEMENT DETAILS
- PROVIDE TIMBER STUD WALL CONSTRUCTION WITH 75mm INSULCLAD WALL PANELS WITH SELECT PAINT FINISH TO FIRST FLOOR

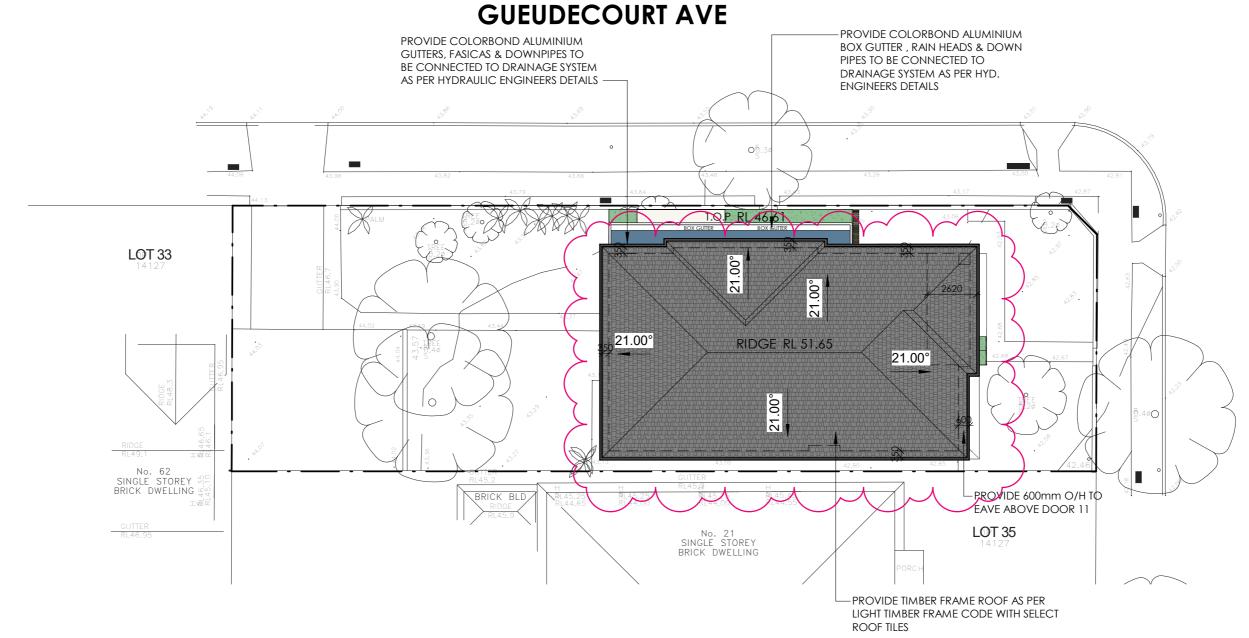

PROPOSED SITE & ROOF PLAN

1 1:200

- AME	NDMENT NOTES: ISSUE D - 12/09/2023 END ROOF RIDGE IERAL REVIEW OF WINDOWS				CLIENT MR STAMATIS DRAKOS	ALTERATIONS & ADDITIONS - FIRST FLOOR ADDITION	DRAWING TI PROPC	DSED SITE PLAN		
D	SECTION 4.55 - MODIFICATION TO DA	12-09-2023	D.P	E.J.S			SHEET NO:	03	ISSUE:	D
С	CONSTRUCTION CERTIFICATE	28-07-21	M.K	E.J.S	ADDRESS	PROJECT STATUS				
В	ADDITIONAL INFORMATION FOR COUNCIL LETTER	25-06-21	M.K	E.J.S	19 EARLWOOD AVENUE	SECTION 4.55 - MODIFICATION	SCALE:	1 : 200@A3	JOB NO:	888 1539
A	DEVELOPMENT APPLICATION	19-05-2021	M.K	E.J.S	19 EARLWOOD AVENUE	SECTION 4.33 - MODIFICATION		_		
ISSUE	AMENDMENTS	DATE	DRN	CHK			DESIGN: E	JS DRAWN: D.P	CHECKED BY:	E.J.S
			1							

EARL FABLY QOD AVENUE












COPYRIGHT of designs shown heron is retained by DESIGN STUDIO 407. Authority is required for any reproduction. Contractor(s) to verify all dimensions on site before

commencing work. Figured dimensions given are to be taken in preference to scaling.



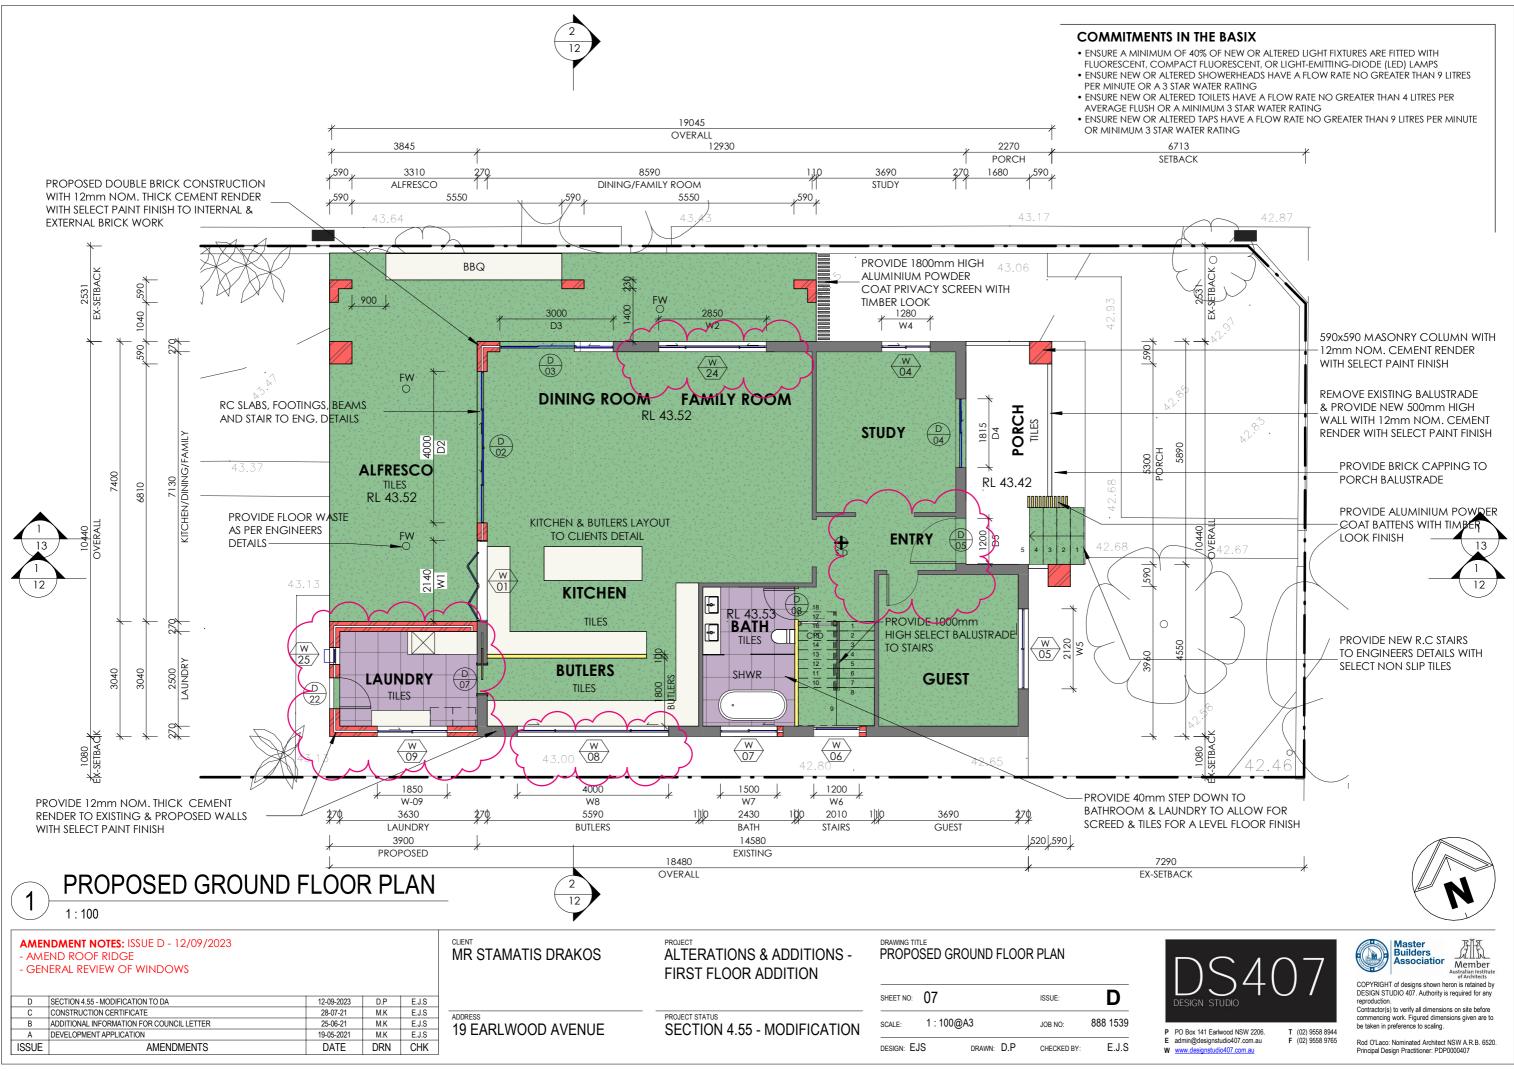

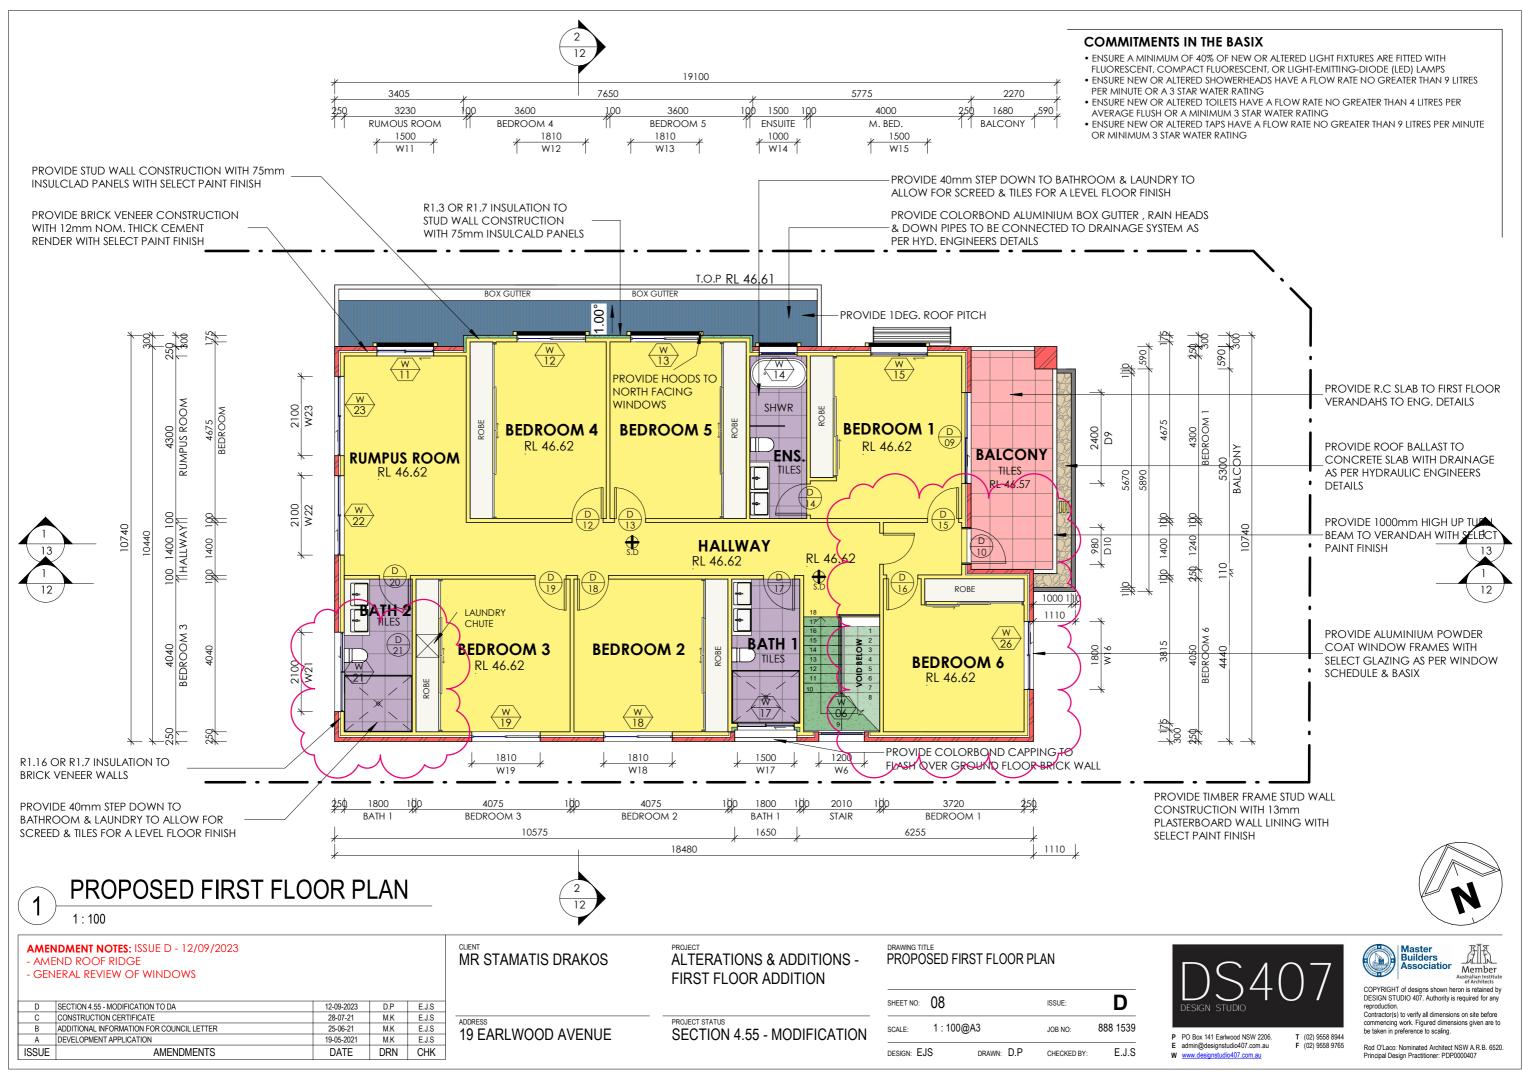

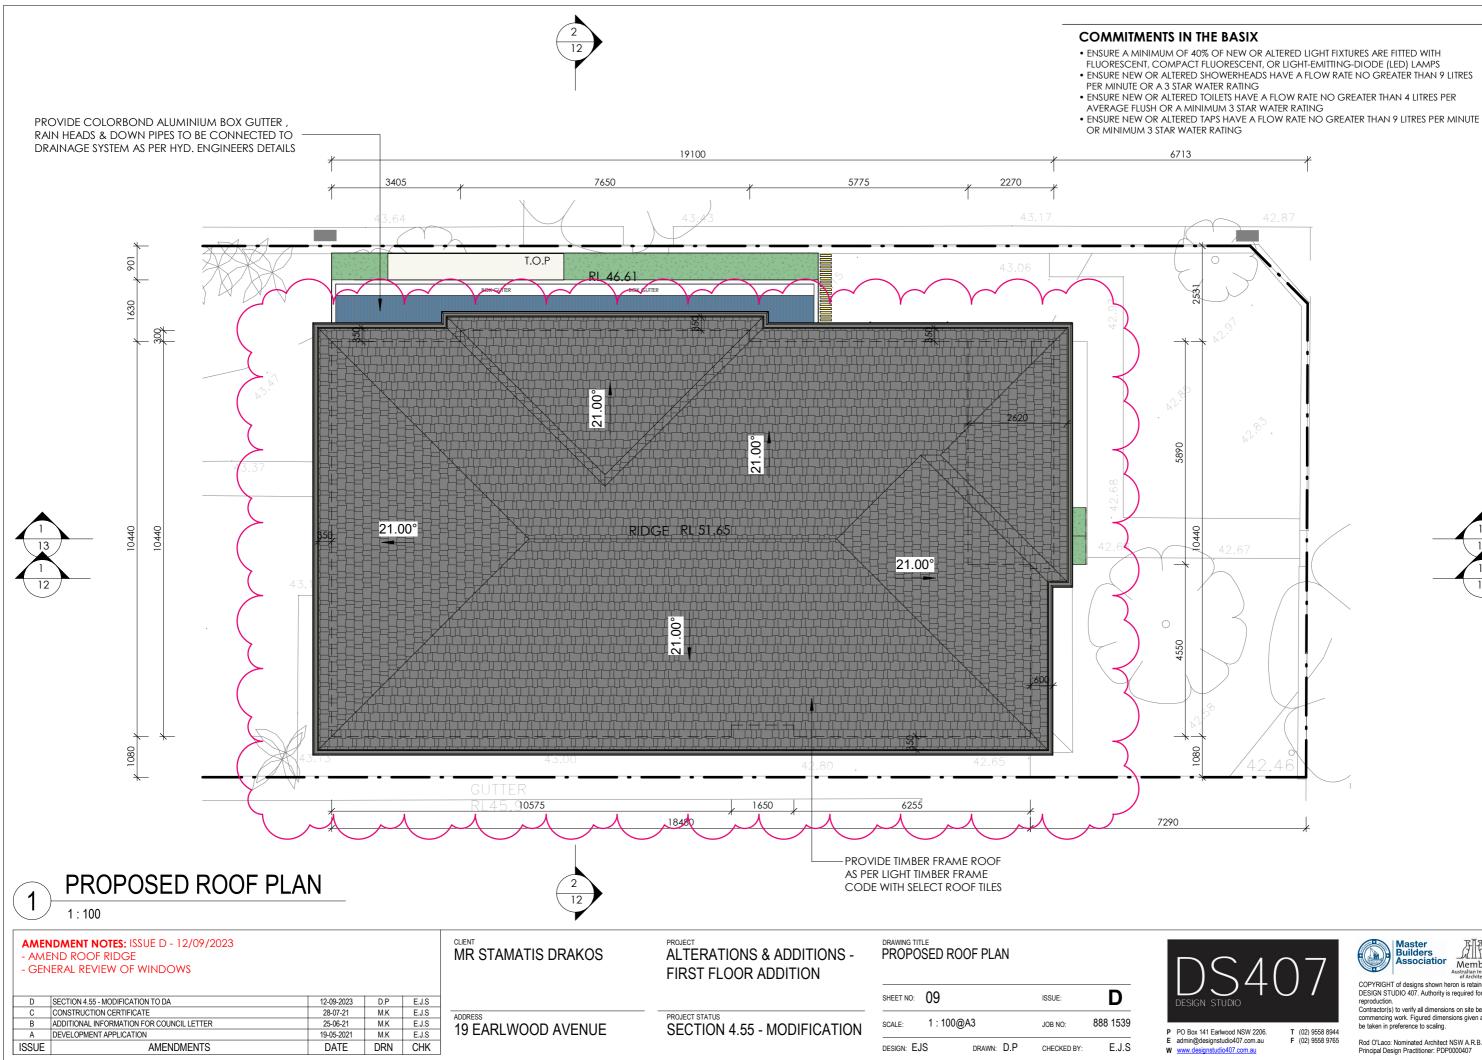









COPYRIGHT of designs shown heron is retained by DESIGN STUDIO 407. Authority is required for any reproduction. Contractor(s) to verify all dimensions on site before

commencing work. Figured dimensions given are to be taken in preference to scaling.

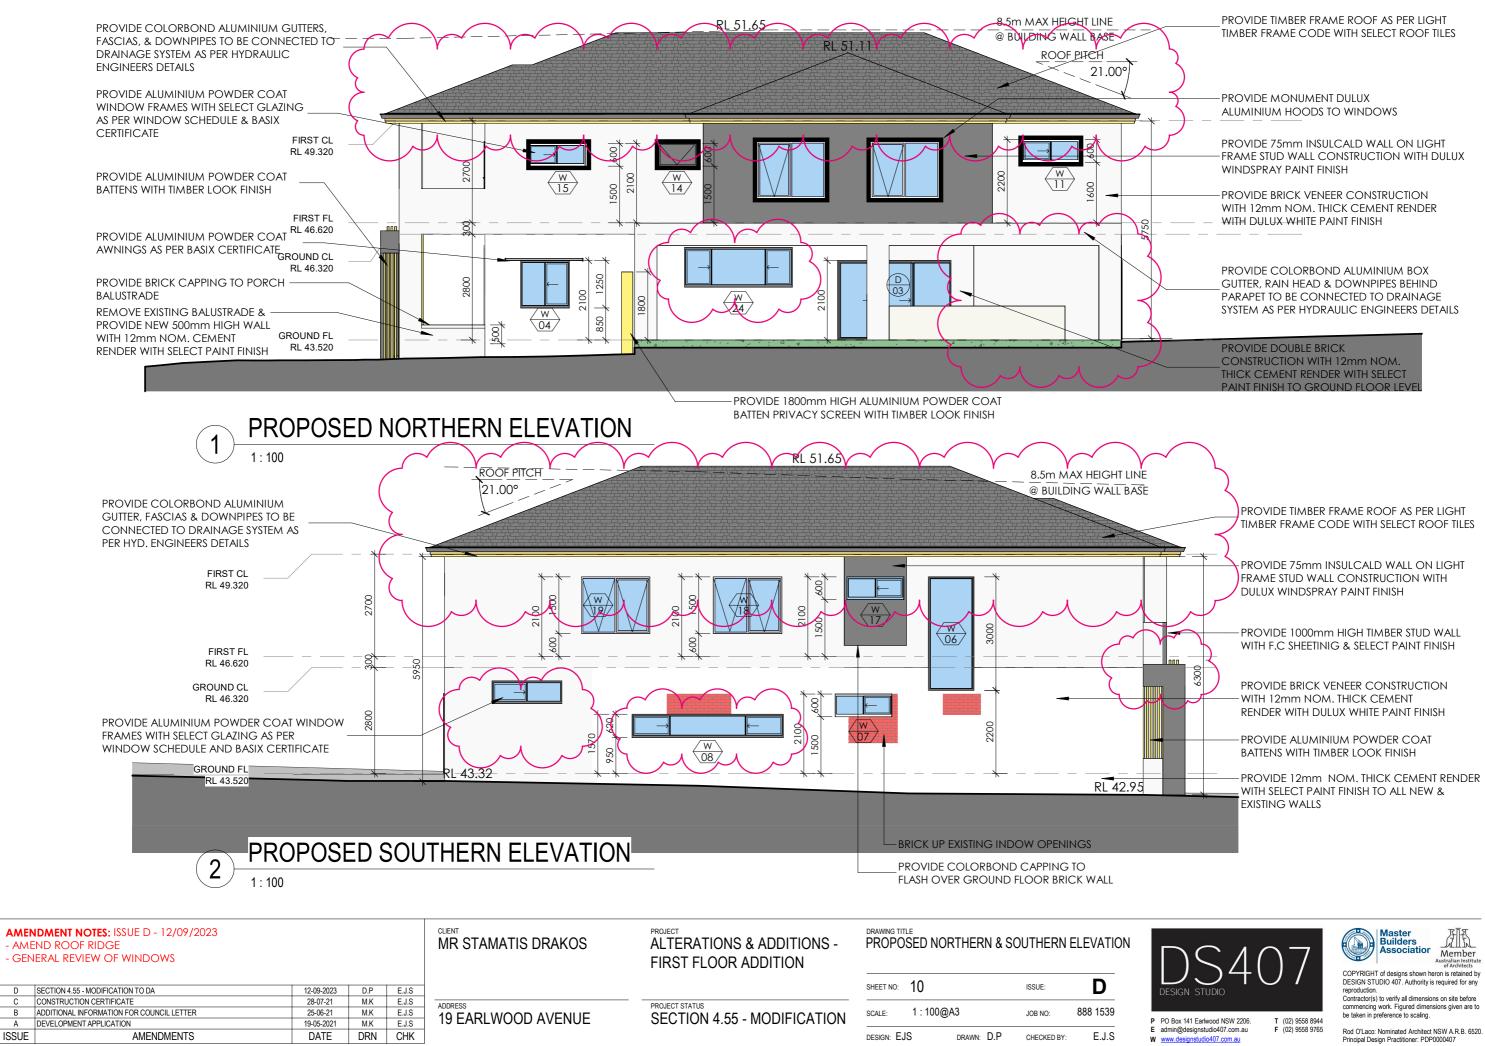



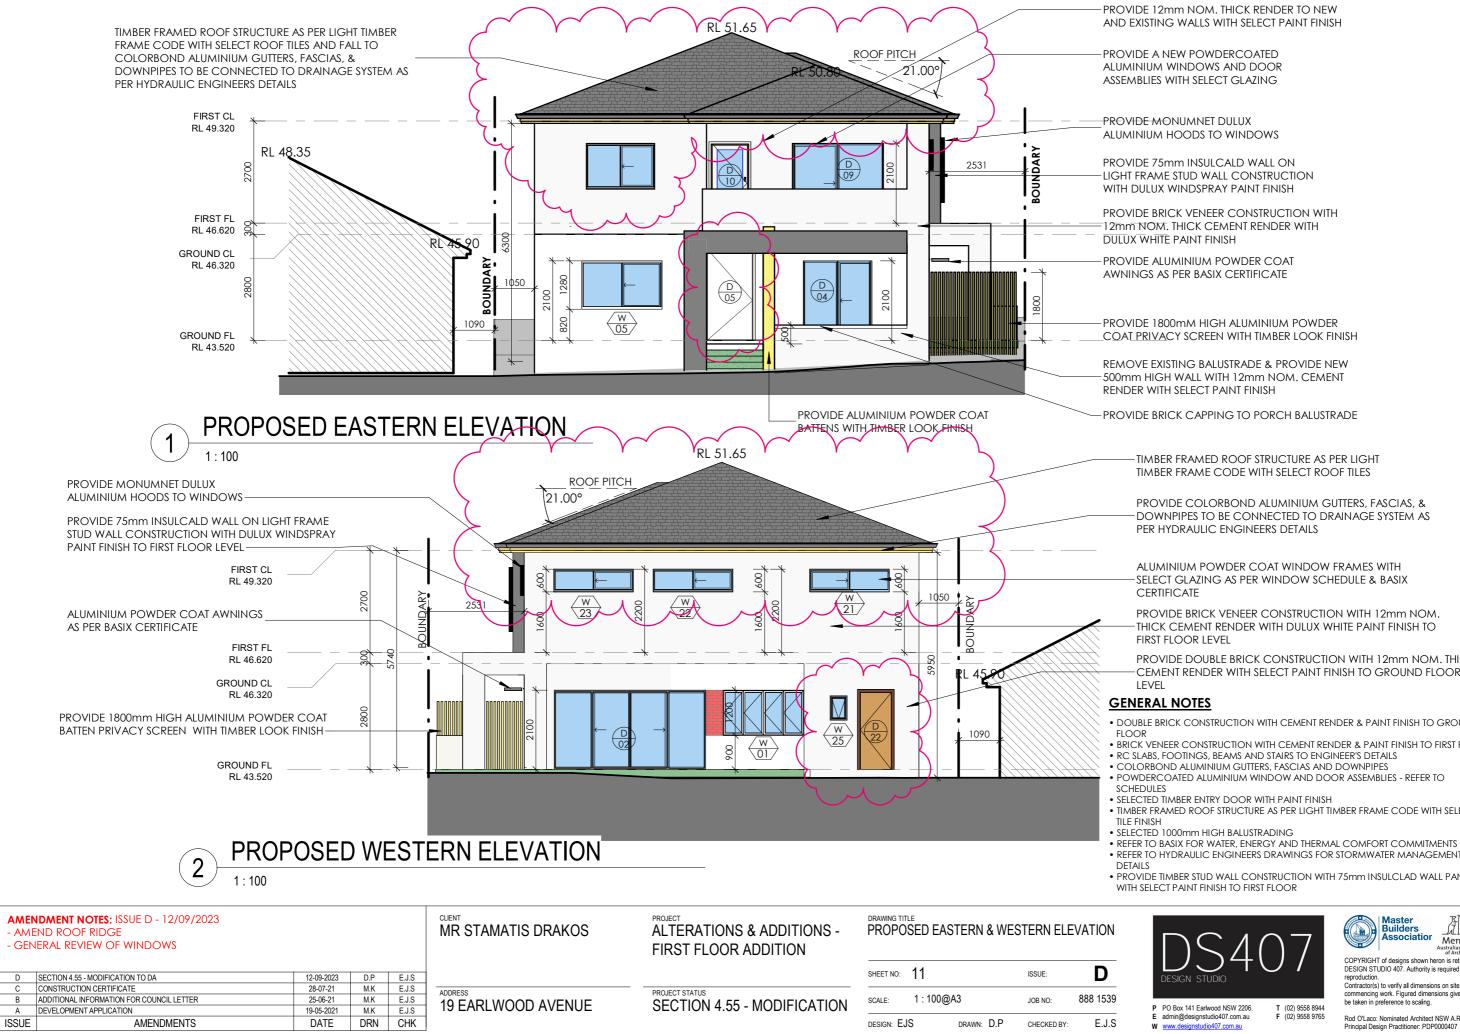

TIMBER FRAMED ROOF STRUCTURE AS PER LIGHT TIMBER FRAME CODE WITH SELECT ROOF TILES

PROVIDE COLORBOND ALUMINIUM GUTTERS, FASCIAS, & DOWNPIPES TO BE CONNECTED TO DRAINAGE SYSTEM AS

ALUMINIUM POWDER COAT WINDOW FRAMES WITH SELECT GLAZING AS PER WINDOW SCHEDULE & BASIX

PROVIDE BRICK VENEER CONSTRUCTION WITH 12mm NOM. THICK CEMENT RENDER WITH DULUX WHITE PAINT FINISH TO

PROVIDE DOUBLE BRICK CONSTRUCTION WITH 12mm NOM. THICK CEMENT RENDER WITH SELECT PAINT FINISH TO GROUND FLOOR

• DOUBLE BRICK CONSTRUCTION WITH CEMENT RENDER & PAINT FINISH TO GROUND

• BRICK VENEER CONSTRUCTION WITH CEMENT RENDER & PAINT FINISH TO FIRST FLOOR • RC SLABS, FOOTINGS, BEAMS AND STAIRS TO ENGINEER'S DETAILS

• POWDERCOATED ALUMINIUM WINDOW AND DOOR ASSEMBLIES - REFER TO

• TIMBER FRAMED ROOF STRUCTURE AS PER LIGHT TIMBER FRAME CODE WITH SELECTED

REFER TO HYDRAULIC ENGINEERS DRAWINGS FOR STORMWATER MANAGEMENT


PROVIDE TIMBER STUD WALL CONSTRUCTION WITH 75mm INSULCLAD WALL PANELS






COPYRIGHT of designs shown heron is retained by DESIGN STUDIO 407. Authority is required for any reproduction

Contractor(s) to verify all dimensions on site before commencing work. Figured dimensions given are to be taken in preference to scaling.

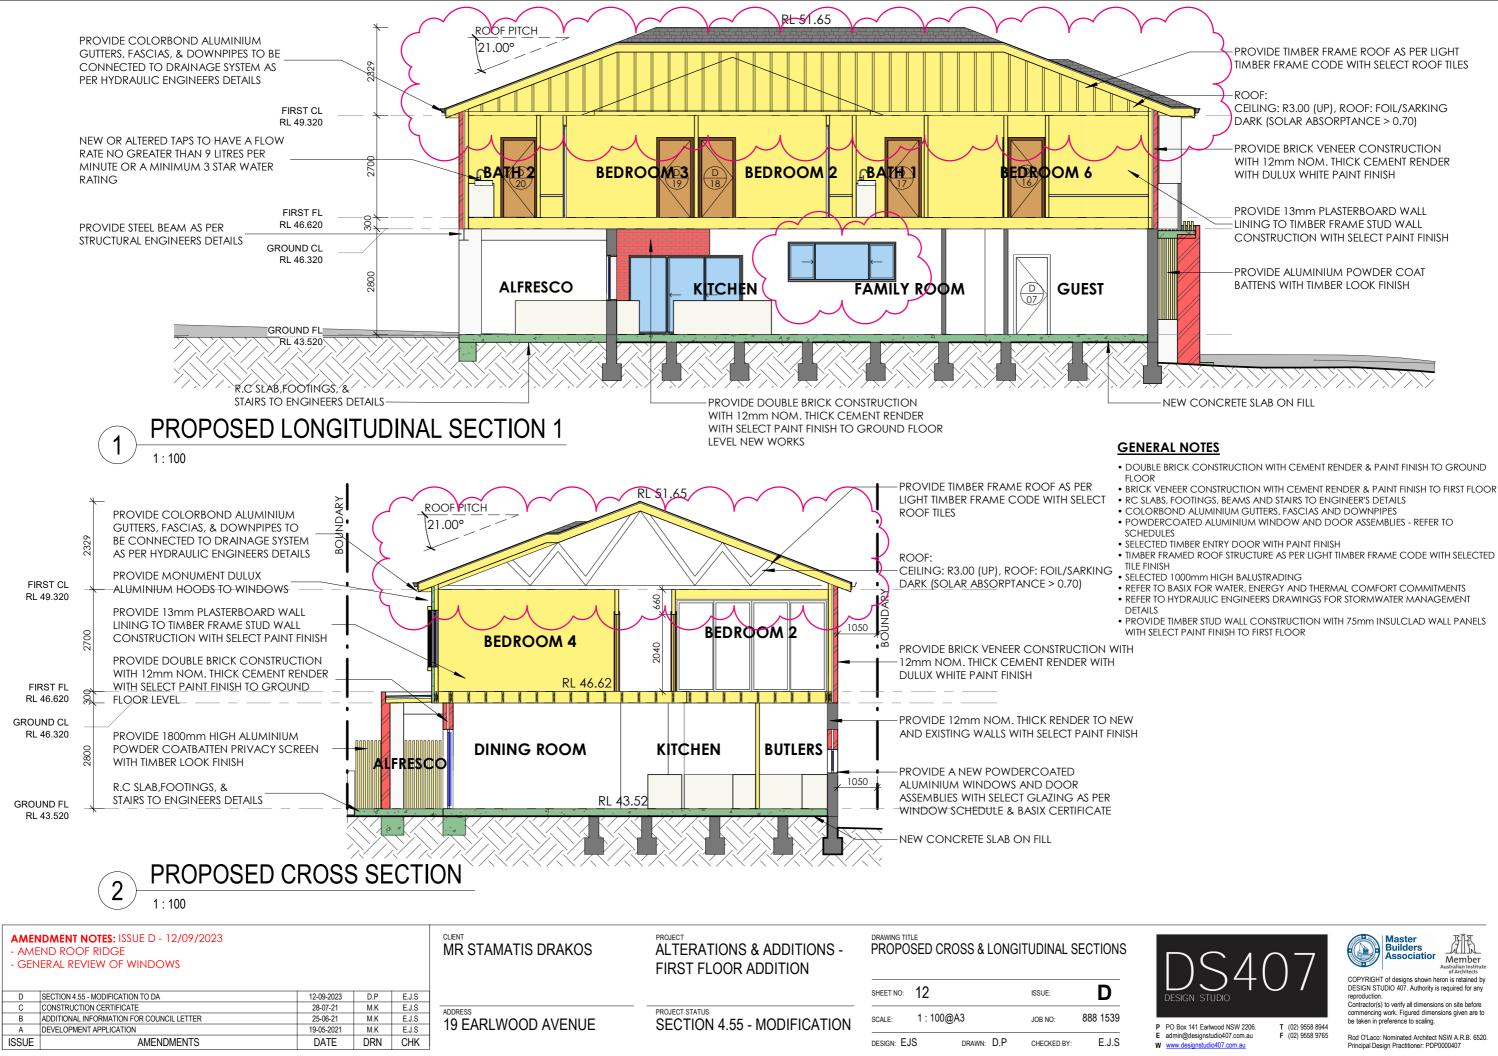

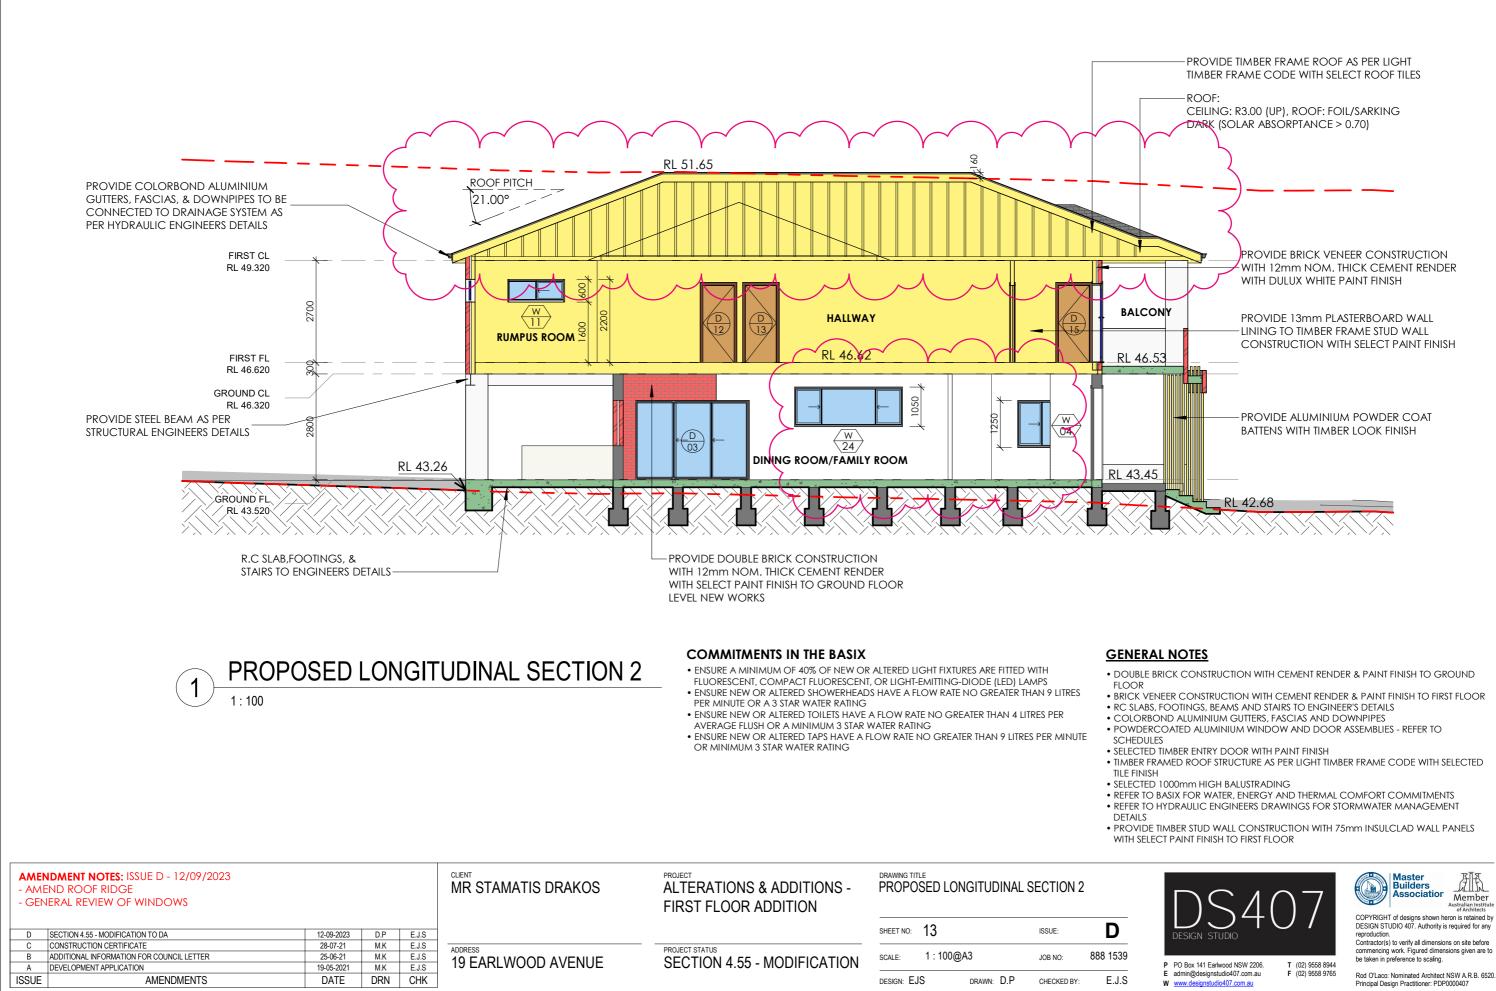

~	\sim	5				WINDOW SCHEDULE	
Level	Mark	Height	Width	Window Area	Head Height	Description	Basix Requirments
GROUNDFL	01	1200	2140	2.57	2100	Alum. Frame Bi-Fold Window w/ 6.38mm Lam. Clear Glazing	STANDARD ALUMINIUM, SINGLE CLEAR, (OR U-VALUE: 7.63, SHGC: 0.75)
GROUND	04	1250	1280	1.60	2100	Alum. Frame Sliding Window w/ 6.38mm Lam. Clear Glazing	STANDARD ALUMINIUM, SINGLE CLEAR, (OR U-VALUE: 7.63, SHGC: 0.75)
GROUND PL	05	1280	2120	2.71	2100	Alum. Frame Sliding Window w/ 6.38mm Lam. Clear Glazing	STANDARD ALUMINIUM, SINGLE CLEAR, (OR U-VALUE: 7.63, SHGC: 0.75)
GROUND FL	06	3000	1200	3.60	5200	Alum. Frame Fixed Window w/ 6.38mm Lam. Clear Glazing	STANDARD ALUMINIUM, SINGLE CLEAR, (OR U-VALUE: 7.63, SHGC: 0.75)
GROUND FL	07	600	1500	0.90	2100	Alum. Frame Sliding Window w/ 6.38mm Lam. Clear Glazing	STANDARD ALUMINIUM, SINGLE CLEAR, (OR U-VALUE: 7.63, SHGC: 0.75)
GROUNDFL	08	620	4000	2.48	1570	Alum. Frame Sliding Window w/ 6.38mm Lam. Clear Glazing	STANDARD ALUMINIUM, SINGLE CLEAR, (OR U-VALUE: 7.63, SHGC: 0.75)
GROUND EL	09	600	1850	1.11	2450	Alum. Frame Sliding Window w/ 6.38mm Lam. Clear Glazing	STANDARD ALUMINIUM, SINGLE CLEAR, (OR U-VALUE: 7.63, SHGC: 0.75)
GROUND FL	24	1050	2850	2.99	2450	Alum. Frame Sliding Window w/ 6.38mm Lam. Clear Glazing	STANDARD ALUMINIUM, SINGLE CLEAR, (OR U-VALUE: 7.63, SHGC: 0.75)
GROUND FL	25	640	450	0.29	1946	Alum. Frame Awning Window w/ 6.38mm Lam. Clear Glazing	STANDARD ALUMINIUM, SINGLE CLEAR, (OR U-VALUE: 7.63, SHGC: 0.75)
FIRST N	11	600	1500	0.90	2200	Alum. Frame Sliding Window w/ 6.38mm Lam. Clear Glazing	STANDARD ALUMINIUM, SINGLE CLEAR, (OR U-VALUE: 7.63, SHGC: 0.75)
FIRST FL	12	1500	1810	2.72	2150	Alum. Frame 2 Panel Awning Window w/ 6.38mm Lam. Low-E glass	STANDARD ALUMINIUM, SINGLE PYROLYTIC LOW-E, (U-VALUE: 5.7, SHGC: 0.47)
FIRST FL	13	1500	1810	2.72	2150	Alum. Frame 2 Panel Awning Window w/ 6.38mm Lam. Low-E glass	STANDARD ALUMINIUM, SINGLE PYROLYTIC LOW-E, (U-VALUE:5.7, SHGC:0.47)
FIRST FL	14	600	1000	0.60	2100	Alum. Frame Awning Window w/ 6.38mm Lam. Obscure Glazing	STANDARD ALUMINIUM, SINGLE CLEAR, (OR U-VALUE: 7.63, SHGC: 0.75)
FIRST FL	15	600	1500	0.90	2100	Alum. Frame Sliding Window w/ 6.38mm Lam. Clear Glazing	STANDARD ALUMINIUM, SINGLE CLEAR, (OR U-VALUE: 7.63, SHGC: 0.75)
FIRST FL	17	600	1500	0.90	2100	Alum. Frame Sliding Window w/ 6.38mm Lam. Clear Glazing	STANDARD ALUMINIUM, SINGLE CLEAR, (OR U-VALUE: 7.63, SHGC: 0.75)
FIRST FL	18	1500	1810	2.72	2100	Alum. Frame 2 Panel Awning Window w/ 6.38mm Lam. Clear Glazing	STANDARD ALUMINIUM, SINGLE CLEAR, (OR U-VALUE: 7.63, SHGC: 0.75)
FIRST FL	19	1500	1810	2.72	2100	Alum. Frame 2 Panel Awning Window w/ 6.38mm Lam. Clear Glazing	STANDARD ALUMINIUM, SINGLE CLEAR, (OR U-VALUE: 7.63, SHGC: 0.75)
FIRST FL	21	600	2100	1.26	2200	Alum. Frame Sliding Window w/ 6.38mm Lam. Clear Glazing	STANDARD ALUMINIUM, SINGLE CLEAR, (OR U-VALUE: 7.63, SHGC: 0.75)
FIRST FL	22	600	2100	1.26	2200	Alum. Frame Sliding Window w/ 6.38mm Lam. Clear Glazing	STANDARD ALUMINIUM, SINGLE CLEAR, (OR U-VALUE: 7.63, SHGC: 0.75)
FIRST FL	23	600	2100	1.26	2200	Alum. Frame Sliding Window w/ 6.38mm Lam. Clear Glazing	STANDARD ALUMINIUM, SINGLE CLEAR, (OR U-VALUE: 7.63, SHGC: 0.75)
FIRST FL	26	1200	1800	2.16	2100	Alum. Frame Sliding Window w/ 6.38mm Lam. Clear Glazing	STANDARD ALUMINIUM, SINGLE PYROLYTIC LOW-E, (U-VALUE: 5.7, SHGC: 0.47)

NOTE: WINDOWS; 02, 03, 10 & 20 HAVE BEEN REMOVED

- AMI	NDMENT NOTES: ISSUE D - 12/09/2023 END ROOF RIDGE NERAL REVIEW OF WINDOWS				MR STAMATIS DRAKOS	ALTERATIONS & ADDITIONS - FIRST FLOOR ADDITION	DRAWING T		IDOW SCHEI	DULE	
D	SECTION 4.55 - MODIFICATION TO DA	12-09-2023	D.P	E.J.S			SHEET NO:	14		ISSUE:	D
С	CONSTRUCTION CERTIFICATE	28-07-21	M.K	E.J.S	ADDRESS	PROJECT STATUS					
В	ADDITIONAL INFORMATION FOR COUNCIL LETTER	25-06-21	M.K	E.J.S	19 EARLWOOD AVENUE	SECTION 4.55 - MODIFICATION	SCALE:	@A3		JOB NO:	888 1539
A	DEVELOPMENT APPLICATION	19-05-2021	M.K	E.J.S	19 EARLWOOD AVENUE	SECTION 4.33 - MODIFICATION		-			
ISSUE	AMENDMENTS	DATE	DRN	CHK			DESIGN: E	JS	DRAWN: D.P	CHECKED BY:	E.J.S

Y:\AAA-DRAWING FILES\888-1539\02 - DRAWING FILES\REVIT\03 - DWELLING DRAWINGS\888-1539 - 19 Earlwood Ave, Earlwood.rvt







Master builders of COPYRIGHT of designs shown heron is retained by DESIGN STUDIO 407. Authority is required for any reproduction. Contractor(s) to verify all dimensions on site before commencing work. Figured dimensions given are to be taken in preference to scaling.

Level Mark	Height	Width	Door Area	Description	Basix Requirements
ROUND FL 02	2100	4000	8.40	Alum. Frame Sliding Door w/ 6.38mm Lam. Clear Glazing	STANDARD ALUMINIUM, SINGLE CLEAR, (OR U-VALUE: 7.63, SHGC: 0.75)
ROUND FL 03	2100	3000	6.30	Alum. Frame Sliding Door w/ 6.38mm Lam. Clear Glazing	STANDARD ALUMINIUM, SINGLE CLEAR, (OR U-VALUE: 7.63, SHGC: 0.75)
ROUND FL 04	2100	1815	3.81	Alum. Frame Sliding Door w/ 6.38mm Lam. Clear Glazing	STANDARD ALUMINIUM, SINGLE CLEAR, (OR U-VALUE: 7.63, SHGC: 0.75)
DUND FL 07	2040	820	1.67	Timber Hollow Core Cavity Sliding Door	N/A
DUNIO FL 08	2040	820	1.67	Timber Solid Core Internal Single Swing Door	N/A
OUND FL 22	2040	820	1.67	Timber Solid Core Internal Single Swing Door	N/A
FIRST FL 09	2100	2400	5.04	Alum. Frame Sliding Door w/ 6.38mm Lam. Clear Glazing	STANDARD ALUMINIUM, SINGLE CLEAR, (OR U-VALUE: 7.63, SHGC: 0.75)
RST FL 10	2040	920	1.88	Alum. Frame Glazed Single Swing Door	STANDARD ALUMINIUM, SINGLE CLEAR, (OR U-VALUE: 7.63, SHGC: 0.75)
IRSTEL 12	2040	820	1.67	Timber Solid Core Internal Single Swing Door	N/A
IRST FL 13	2040	820	1.67	Timber Solid Core Internal Single Swing Door	N/A
RST FI 14	2040	820	1.67	Timber Solid Core Internal Single Swing Door	N/A
RST FL 15	2040	820	1.67	Timber Solid Core Internal Single Swing Door	N/A
RST FL 16	2040	820	1.67	Timber Solid Core Internal Single Swing Door	N/A
RSTEL 17	2040	820	1.67	Timber Solid Core Internal Single Swing Door	N/A
IRST FL 18	2040	820	1.67	Timber Solid Core Internal Single Swing Door	N/A
RST F	2040	820	1.67	Timber Solid Core Internal Single Swing Door	N/A
RST FL 20	2040	820	1.67	Timber Solid Core Internal Single Swing Door	N/A
STFL 21	600	400	0.24	Timber Solid Core Internal Single Swing Door	N/A
RSTEL 23	2040	820	1.67	Timber Solid Core Internal Single Swing Door	N/A

NOTE: DOORS; 01, 06, 10 & 11 HAVE BEEN REMOVED

- AM	NDMENT NOTES: ISSUE D - 12/09/2023 END ROOF RIDGE IERAL REVIEW OF WINDOWS				CLIENT MR STAMATIS DRAKOS	PROJECT ALTERATIONS & ADDITIONS - FIRST FLOOR ADDITION	DRAWING T	DSED DOOR SCH	EDULE	
D	SECTION 4.55 - MODIFICATION TO DA	12-09-2023	D.P	E.J.S			SHEET NO:	15	ISSUE:	D
С	CONSTRUCTION CERTIFICATE	28-07-21	M.K	E.J.S	ADDRESS	PROJECT STATUS				
В	ADDITIONAL INFORMATION FOR COUNCIL LETTER	25-06-21	M.K	E.J.S	19 EARLWOOD AVENUE	SECTION 4.55 - MODIFICATION	SCALE:	@A3	JOB NO:	888 1539
Α	DEVELOPMENT APPLICATION	19-05-2021	M.K	E.J.S	19 EARLWOOD AVENUE	SECTION 4.33 - MODIFICATION		-		
ISSUE	AMENDMENTS	DATE	DRN	CHK			DESIGN: E	JS DRAWN:	О.Р снескер	BY: E.J.S
L										







COPYRIGHT of designs shown heron is retained by DESIGN STUDIO 407. Authority is required for any reproduction.

BASIX REQUIREMENTS:

BASIX[°]Certificate

Building Sustainability Index www.basix.nsw.gov.au Alterations and Additions

Certificate number: A413995_02

This certificate confirms that the proposed development will meet the NSW government's requirements for sustainability, if it is built in accordance with the commitments set out below. Terms used in this certificate, or in the commitments, have the meaning given by the document entitled TAASIX Alterations and Additions Definitions' dated 00/10/2017 publicated by the Department. This document is available at www.basix.nsw.gov.au

This certificate is a revision of certificate number A413995 lodged with the consent authority or certifier on 24 May 2021 with application DA409/2021.

It is the responsibility of the applicant to verify with the consent authority that the original, or any revised certificate, complies with the requirements of Sch 1 Cl 2A, 4A or 6A of the Environmental Planning and Assessment Reoulation 2000

Secretary Date of issue: Tuesday, 12, September 2023 To be valid, this certificate must be lodged within 3 months of the date of issue.



Certificate Prepared by (please complete before submitting to Council or PCA) Name / Company Name: Building & Energy Consultants Australia ABN (if applicable): 92122407783

Separate dwelling house

19 EARLWOOD AVE_02 19 EARLWOOD Avenue EARLWOOD 2206

My renovation work is valued at \$50,000 or more, and does not include a pool (and/or spa).

 Project name
 19 Even...

 Project name
 19 Even...

 Street address
 19 EARLWOOD Avenue E

 Local Government Area
 Canterbury City Council

 Plan type and number
 Deposited Plan 14127

 1 et number
 34

Fixtures and systems	Show on DA Plans	Show on CC/CDC Plans & specs	Certifier Check
Lighting			
The applicant must ensure a minimum of 40% of new or altered light fixtures are fitted with fluorescent, compact fluorescent, or light-emitting-diode (LED) lamps.		~	~
Fixtures			
The applicant must ensure new or altered showerheads have a flow rate no greater than 9 litres per minute or a 3 star water rating.		~	~
The applicant must ensure new or altered toilets have a flow rate no greater than 4 litres per average flush or a minimum 3 star water rating.		~	~
The applicant must ensure new or altered taps have a flow rate no greater than 9 litres per minute or minimum 3 star water rating.		~	

projec

of

iption

0

Project type

Dwelling type

Type of alteration and addition

Construction			Show on DA Plans	Show on CC/CDC Plans & specs	Certifier Check
nsulation requirements					
	d construction (floor(s), walls, and ceilings/roofs) tion is not required where the area of new constr where insulation already exists.		~	~	~
Construction	Additional insulation required (R-value)	Other specifications			
concrete slab on ground floor.	nil				
suspended floor with open subfloor: framed (R0.7).	R0.8 (down) (or R1.50 including construction)				
external wall: cavity brick	nil				
external wall: brick veneer	R1.16 (or R1.70 including construction)				
external wall: framed (weatherboard, fibro, metal clad)	R1.30 (or R1.70 including construction)				
flat ceiling, pitched roof	ceiling: R3.00 (up), roof: foil/sarking	dark (solar absorptance > 0.70)			

Glazing requ	irements						Shc DA
Window / door no.	Orientation	Area of glass inc. frame (m2)	Oversha Height (m)	adowing Distance (m)	Shading device	Frame and glass type	
D4	E	3.81	0	0	projection/height above sill ratio >=0.43	standard aluminium, single clear, (or U-value: 7.63, SHGC: 0.75)	
W5	E	2.71	0	0	projection/height above sill ratio >=0.43	standard aluminium, single clear, (or U-value: 7.63, SHGC: 0.75)	
W6	s	2.48	0	0	none	standard aluminium, single clear, (or U-value: 7.63, SHGC: 0.75)	
W7	S	0.9	0	0	none	standard aluminium, single clear, (or U-value: 7.63, SHGC: 0.75)	
W8	S	2.548	0	0	none	standard aluminium, single clear, (or U-value: 7.63, SHGC: 0.75)	
W9	S	1.11	0	0	none	standard aluminium, single clear, (or U-value: 7.63, SHGC: 0.75)	
W25	W	0.29	0	0	none	standard aluminium, single clear, (or U-value: 7.63, SHGC: 0.75)	
W11	N	0.9	0	0	projection/height above sill ratio >=0.43	standard aluminium, single clear, (or U-value: 7.63, SHGC: 0.75)	
W12	N	2.72	0	0	projection/height above sill ratio >=0.23	standard aluminium, single pyrolytic low-e, (U-value: 5.7, SHGC: 0.47)	
W13	N	2.72	0	0	projection/height above sill ratio >=0.23	standard aluminium, single pyrolytic low-e, (U-value: 5.7, SHGC: 0.47)	
W14	N	0.6	0	0	projection/height above sill ratio >=0.43	standard aluminium, single clear, (or U-value: 7.63, SHGC: 0.75)	
W15	N	0.9	0	0	projection/height above sill ratio >=0.43	standard aluminium, single clear, (or U-value: 7.63, SHGC: 0.75)	
D9	E	5.04	0	0	projection/height above sill ratio >=0.43	standard aluminium, single clear, (or U-value: 7.63, SHGC: 0.75)	

Glazing requirements								
Window / door no.	Orientation	Area of	Oversh	adowing	Shading device	Frame and glass type		
		glass inc. frame (m2)	Height (m)	Distance (m)				
D10	E	1.88	0	0	projection/height above sill ratio >=0.43	standard aluminium, single clear, (or U-value: 7.63, SHGC: 0.75)		
W26	E	2.16	0	0	projection/height above sill ratio >=0.29	standard aluminium, single pyrolytic low-e, (U-value: 5.7, SHGC: 0.47)		
W17	s	0.9	0	0	projection/height above sill ratio >=0.43	standard aluminium, single clear, (or U-value: 7.63, SHGC: 0.75)		
W18	S	2.72	0	0	projection/height above sill ratio >=0.23	standard aluminium, single clear, (or U-value: 7.63, SHGC: 0.75)		
W19	S	2.72	0	0	projection/height above sill ratio >=0.23	standard aluminium, single clear, (or U-value: 7.63, SHGC: 0.75)		
W21	w	1.26	0	0	projection/height above sill ratio >=0.43	standard aluminium, single clear, (or U-value: 7.63, SHGC: 0.75)		
W22	w	1.26	0	0	projection/height above sill ratio >=0.43	standard aluminium, single clear, (or U-value: 7.63, SHGC: 0.75)		
W23	w	1.26	0	0	projection/height above sill ratio >=0.43	standard aluminium, single clear, (or U-value: 7.63, SHGC: 0.75)		

Glazing requirements							Show on DA Plans	Show on CC/CDC Plans & specs	Certifie Check
Windows and	glazed do	ors							
					hading devices, in accordance with or each window and glazed door.	the specifications listed in the table below.	~	\checkmark	~
The following re	equirements r	nust also	be satisfi	ied in relatio	n to each window and glazed door:			~	~
have a U-value	and a Solar	Heat Gair	n Coefficie	ent (SHGC)		d glass may either match the description, or, le below. Total system U-values and SHGCs i.		~	~
have a U-value must be calcula	and a Solar ted in accord	Heat Gair lance with	n Coefficie h National	ent (SHGC) Fenestratio	no greater than that listed in the tab	ar glazing, or toned/air gap/clear glazing must le below. Total system U-values and SHGCs . The description is provided for information		~	~
For projections least that shown	described as n in the table	a ratio, ti below.	he ratio o	f the projecti		the window or glazed door sill must be at	~	~	~
For projections least that shown	described as n in the table	a ratio, ti below.	he ratio of	f the projecti equireme		the window or glazed door sill must be at Frame and glass type	~	~	~
	described as n in the table	a ratio, ti below.	he ratio of	f the projecti equireme	ents		~	~	~
For projections least that shown Windows an Window / door	described as n in the table	a ratio, ti below. doors g Area of glass inc. frame	he ratio of lazing r Oversha Height	f the projecti equireme adowing Distance	ents		V	~	~
Windows an Windows an Window / door no.	described as n in the table of glazed of Orientation	a ratio, ti below. doors g Area of glass inc. frame (m2)	he ratio of lazing r Oversha Height (m)	f the projecti equireme adowing Distance (m)	nts Shading device projection/height above sill ratio	Frame and glass type standard aluminium, single clear, (or	~	~	~
For projections least that shown Windows an Window / door no. W1	described as n in the table d glazed o Orientation	a ratio, the below. Area of glass inc. frame (m2) 2.57	he ratio of lazing r Oversha Height (m)	f the projecti equireme adowing Distance (m) 0	nts Shading device projection/height above sill ratio >=0.43 projection/height above sill ratio	Frame and glass type standard aluminium, single clear, (or U-value: 7.63, SHGC: 0.75) standard aluminum, single clear, (or	~	~	~
For projections least that shown Windows an Window / door no.	described as n in the table d glazed o Orientation W	a a ratio, the below.	he ratio of lazing r Oversha Height (m) 0	f the projecti equireme adowing Distance (m) 0	shading device projection/height above sill ratio >=0.43 projection/height above sill ratio >=0.43 projection/height above sill ratio	Frame and glass type standard aluminium, single clear, (or U-value: 7.63, SHGC: 0.75) standard aluminium, single clear, (or U-value: 7.63, SHGC: 0.75) standard aluminium, single clear, (or	~	~	~

AMENDMENT NOTES: ISSUE D - 12/09/2023 CLIENT PROJECT DRAWING TITLE MR STAMATIS DRAKOS ALTERATIONS & ADDITIONS -PROPOSED BASIX COMMITMENTS - AMEND ROOF RIDGE - GENERAL REVIEW OF WINDOWS FIRST FLOOR ADDITION D SHEET NO: 16 ISSUE: D SECTION 4.55 - MODIFICATION TO DA C CONSTRUCTION CERTIFICATE 12-09-2023 D.P E.J.S 28-07-21 M.K E.J.S PROJECT STATUS ADDRESS 25-06-21 M.K E.J.S 19-05-2021 M.K E.J.S В ADDITIONAL INFORMATION FOR COUNCIL LETTER SCALE: @A3 JOB NO: 888 1539 **19 EARLWOOD AVENUE SECTION 4.55 - MODIFICATION** A DEVELOPMENT APPLICATION DRN CHK AMENDMENTS DESIGN: EJS E.J.S ISSUE DATE DRAWN: D.P CHECKED BY:

Y:\AAA-DRAWING FILES\888-1539\02 - DRAWING FILES\REVIT\03 - DWELLING DRAWINGS\888-1539 - 19 Earlwood Ave, Earlwood.rvt

ihow on C/CDC Ilans & pecs	Certifier Check

how on C/CDC lans & pecs	Certifier Check	







COPYRIGHT of designs shown heron is retained by DESIGN STUDIO 407. Authority is required for any reproduction. Contractor(s) to verify all dimensions on site before

commencing work. Figured dimensions given are to be taken in preference to scaling.

B.C.A NCC SPECIFICATIONS

The whole works shall be in accordance with the Building Code of Australia, local council building code and all other governing authorities concerned.

SITE CLEARING

All stumps and roots shall be grubbed out over the building area to a minimum distance of 2000mm clear of the building or to the boundaries of the site whichever is the less, and removed from the site.

FXCAVATOR

Cut and level where necessary under timber framed floors to give a minimum clearance of 400mm under bearers and 500mm under joists. Excavate for all footings and slabs in materials as found and as indicated on architectural and/or structural drawings. Excavations for all footings shall have level bottoms stepped as necessary and taken to even bearing. Remove excavated material from the site unless directed otherwise. Carry out all work necessary to render this trade complete

DRAINER

All sewerage and drainage shall comply with the requirements of Sydney Water. A certificate of compliance to be produced to the owner on completion. Stormwater to be discharged in accordance with the local council's requirements.

CONCRETOR

Concrete work shall generally be in accordance with the relevant Australian Standards and Codes and in particular with A\$ 1480. Concrete specified by strength shall be tested in accordance with A\$ 1480. Ready mixed concrete shall also comply with A\$ 1379 for mixing and delivery. The concrete shall be supplied by an approved firm. Concrete mixed on site shall be in accordance with AS 1465 and AS 1315. Ingredients shall be mixed in a mechanical mixer in the following proportions by volume

Coarse aggregate	(approximate 20mm)	4
Fine aggregate	(sharp sand)	2
Cement	(portland)	1

Keep reinforcement clean and store clear of ground. All reinforced concrete work shall be to Structural Engineer's details.

BRICKI AYER

All masonry construction in accordance with A\$ 3700. All brickwork shall be accurately bonded, carried up true and plumb in level courses to heights and thicknesses as indicated. Exposed brickwork shall be as selected or to match existing. Thoroughly clean down with diluted spirits of salts, wash down with clean water and leave free from stains. Build in galvanised steel lintels, flashing, vents and damp proof courses as required. Galvanised steel lintels shall be as selected from the following table:

SPAN	LINTEL		LENGTH
up to 1200mm	76 x 10	bar	opening + 230mm
up to 1500mm	76 x 76 x 10	angle	opening + 230mm
up to 2400mm	127 x 76 x 10	angle	opening + 450mm
up to 3000mm	152 x 89 x 10	angle	opening + 450mm

Spans greater than 3000mm to Structural Engineer's details.

STRUCTURAL STEEL

Supply, fabricate and erect steelwork shown on the structural engineer's drawings including hoisting and fixing in positions. All work to be in accordance with relevant SAA codes and standards

CARPENTER AND JOINER

Timber used shall be sound, well seasoned and free from defect, accurately cut, fitted and fixed. Timber sizes, centre spacings and spans only apply to the grade indicated. Bearers, floor joists, rathers, battens and other timber framework to be as indicated and/or in accordance with A\$1684 S.A.A. Light Timber Framing Code. Supply and install new windows and doors as indicated. Supply and fix eaves lining to match underside of existing to underside of external ceiling areas. Supply and fix either selected sheet flooring, tongue and groove timber flooring or fibrous cement sheet flooring to floor joists where indicated all in accordance with manufacturer's

recommendations and instructions. Architraves and skirtings to be selected and/or to match existing

ROOFING

Supply and fix roofing specified or as selected in accordance with relevant Australian Standard and manufacturer's instructions. Sheet roofing: Shall be metal sheet roofing without traverse laps that complies with AS 1562 and with manufacturer's instructions. Tile roofing: Shall comply with A\$2050 and manufacturer's instructions.

PLUMBER

All work shall comply with the requirements of, and to the approval of Sydney Water. Extend existing services and connect to new fittings as indicated. Water supply shall be connected to all fittings from the supply authority's water main in accordance with its requirements. All internal works shall be copper tubing with hot water pipes suitably insulated. A certificate of satisfactory completion shall be obtained. Provide selected guttering and downpipe to roof and drain roof water to stormwater line as required

ELECTRICIAN

All work to be carried out in accordance with the supply authority's requirements and the S.A.A. Wiring Rules. Connect into existing service. Provide power points and light points to client's requirements. Smoke detectors to be installed in Class 1A buildings to comply with Clause E1.7 (C) of the building code of Australia.

GLAZIER

Glass and glazing shall be in accordance with A\$ 1288. All glass to be free of defects and of proper weights relative to sheet size. Glazing to be selected or to match existing. Obscure glazing shall be provided as selected and to the proprietor's instructions.

PLASTERER

Gypsum plasterboard sheets for internal wall and ceiling linings shall be of an approved type: 13mm thick for studwork, ceiling joists and/or rafters at 600mm centres, 10mm thick for studwork, ceiling joists and/or rafters at 450mm centres. to be set level and smooth. Line walls as indicated with 6mm Villaboard sheeting fixed to manufacturer's instructions.

All internal brickwork or masonry surfaces as indicated shall be cement rendered in accordance with AS CA27 to a minimum thickness of 13mm. Internal cement render shall be 9 parts clean sand, 1 part fresh cement, 2 parts lime. Make good where new work abuts existing, at new openings and as indicated. Cornice to be selected and/or to match existing.

PAINTER

The proprietor to attend to all painting, staining and varnishing. All paints or other coatings shall be of best quality materials and of approved manufacture. All priming materials shall be of an approved brand acceptable to the manufacture of the finishing coats to be used. All surfaces shall be finished to match existing. External joinery shall be primed on all faces at place of assembly. Where joinery is to be other than painted it shall be treated at place of assembly with a primer having preservative and water repellent properties. All other exposed external woodwork shall be primed at time of fixing and shall receive finish as selected. All internal surfaces shall be suitably and adequately treated to the client's requirements. All exposed metalwork shall receive two coats metal primer, one undercoat, and one coat full gloss. All lined surfaces except where tiled to be given one coat sealer, and two coats of flat plastic paint. All colours to be selected by the proprietor.

INSULATION

Supply and fit selected insulation and sisalation to walls, roofs and ceiling as directed by the proprietor and indicated on plans.

P.C.ITEMS

The P.C. items are to be selected by the owner and installed by the Builder.

COMPLETION

The works shall be complete in every trade. Sashes, doors, locks and all other equipment shall be checked and left in a satisfactory operating condition. Surplus materials and rubbish shall be removed from the site. All to be left clean and fit for occupation with glass cleaned, gutters and drains cleared and all approvals given

Amendment Notes: ISSUE D - 12/09/2023 - Amend Roof Ridge - General Review of Windows					MR STAMATIS DRAKOS	ALTERATIONS & ADDITIONS - FIRST FLOOR ADDITION	DRAWING TITLE B.C.A NCC SPECIFICATIONS			
D	SECTION 4.55 - MODIFICATION TO DA	12-09-2023	D.P	E.J.S			SHEET NO:	17	ISSUE:	D
С	CONSTRUCTION CERTIFICATE	28-07-21	M.K	E.J.S	ADDRESS	PROJECT STATUS				
B ADDITIONAL INFORMATION FOR COUNCIL LETTER 25-06-21 M.K E.J.S					19 EARLWOOD AVENUE	SECTION 4.55 - MODIFICATION	SCALE: 1 : 100@A3		JOB NO:	888 1539
A DEVELOPMENT APPLICATION 19-05-2021 M.K E.J.S										
ISSUE AMENDMENTS DATE DRN CHK		DESIGN: E	JS DRAWN: D.P	CHECKED BY:			E.J.S			
L		1								







COPYRIGHT of designs shown heron is retained by DESIGN STUDIO 407. Authority is required for any

Contractor(s) to verify all dimensions on site before commencing work. Figured dimensions given are to be taken in preference to scaling.